
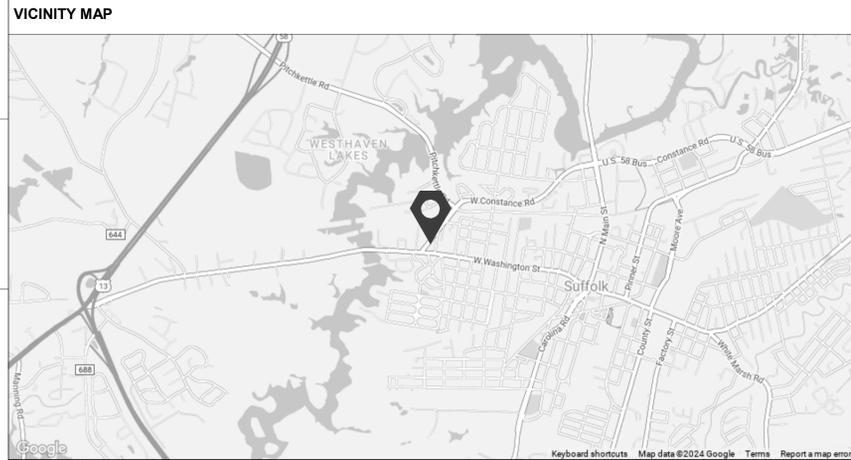
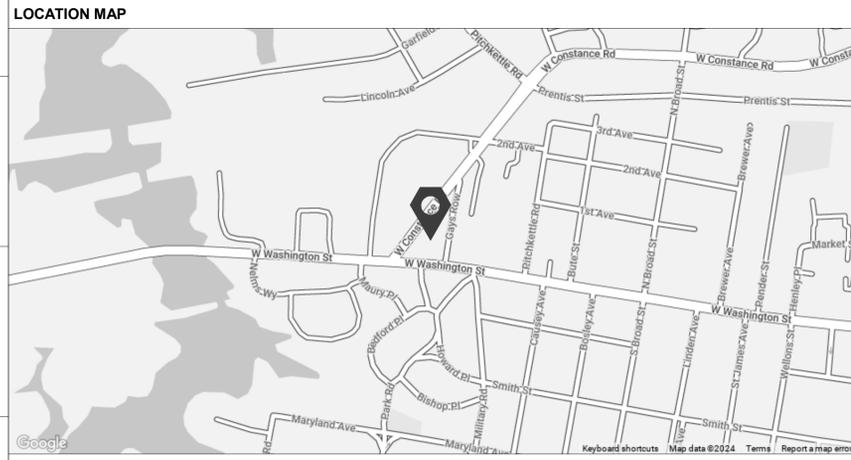


SUFFOLK REDEVELOPMENT HOUSING AUTHORITY

CHOREY PARK FLOORING

804 W CONSTANCE RD, SUFFOLK, VA 23434

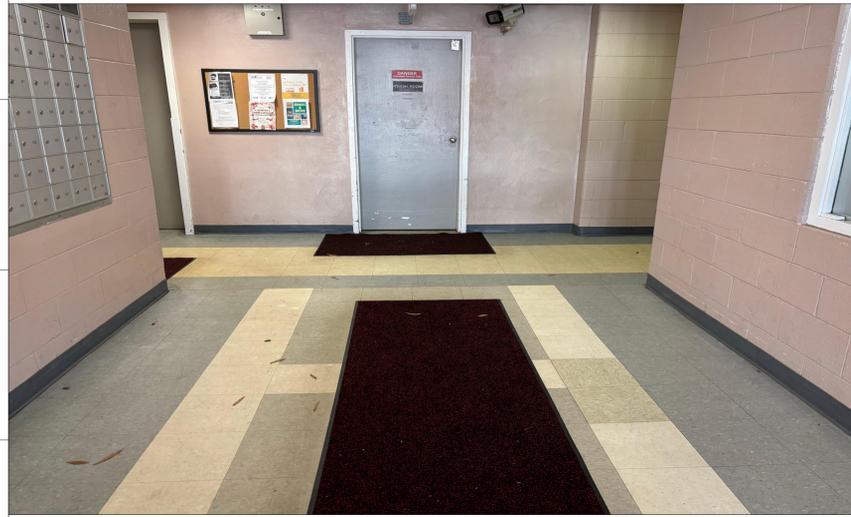

GENERAL NOTES - DEMO

- WHERE IT IS CALLED OUT TO PATCH AND REPAIR AREAS, NEW CONSTRUCTION IS TO MATCH ADJACENT CONSTRUCTION.
- IF HAZARDOUS MATERIAL IS SUSPECTED, CONTRACTOR IS TO NOTIFY THE OWNER AND REMOVE AS REQUIRED BY LAW.
- EXCEPT FOR ITEMS OR MATERIAL TO BE SALVAGED, RECYCLED, OR OTHERWISE REUSED, REMOVE ALL WASTE MATERIALS FROM THE PROJECT SITE AND LEGALLY DISPOSE OF THEM IN A LANDFILL OR INCINERATOR ACCEPTABLE TO AUTHORITIES HAVING JURISDICTION.
- CONTRACTOR IS TO NOTIFY ARCHITECT IMMEDIATELY UPON THE DISCOVERY OF ANY UNFORESEEN CONDITIONS WHICH MAY ALTER THE DEMOLITION PROCESS.
- ALL EXISTING CONSTRUCTION REMAINING IS TO BE PROTECTED DURING DEMOLITION AND BUILD OUT.

SHEET INDEX

SHEET #	SHEET NAME	REVISION #	REV. DATE
TITLE SERIES			
T100	TITLE SHEET		
T101	SPECIFICATIONS AND FINISH SCHEDULE+DETAILS		
DEMOLITION SERIES			
AD101	LEVEL 1 DEMOLITION-FLOOR PLAN		
ARCHITECTURAL SERIES			
A101	LEVEL 1 NEW WORK-FLOOR PLAN		

VIA DESIGN
319 E Plume Street
Norfolk, VA 23510
757 627 1489
viadesignarchitects.com



CONSULTANT:

PROJECT IDENTIFICATION

CLIENT PROJECT NUMBER: XXXXXX
VIA PROJECT NUMBER: 21047-03

PROJECT TEAM

ARCHITECT: VIA DESIGN ARCHITECTS, PC
319 E PLUME STREET
NORFOLK, VA 23510

STRUCTURAL ENGINEER: N/A

CIVIL ENGINEER: N/A

LANDSCAPE ARCHITECT: N/A

MECH., ELEC., PLUMB., ENGINEER: N/A

GENERAL NOTES - NEW WORK

- ALL WORK IS TO BE PERFORMED IN ACCORDANCE WITH ALL APPLICABLE BUILDING CODES, ORDINANCES AND LAWS.
- DO NOT SCALE DRAWINGS. IF DIMENSIONS ARE IN QUESTION, THE CONTRACTOR SHALL BE RESPONSIBLE FOR OBTAINING CLARIFICATION FROM THE ARCHITECT BEFORE PROCEEDING WITH THE WORK.
- DIMENSIONS ARE TO FACE OF STUD, CENTERLINE OF OPENINGS, AND CENTERLINE OF COLUMNS UNLESS OTHERWISE NOTED.
- THE CONTRACTOR SHALL IMMEDIATELY NOTIFY THE ARCHITECT IN WRITING OF ANY DISCREPANCIES. CONTRACTOR IS TO NOTIFY THE ARCHITECT IMMEDIATELY UPON DISCOVERY OF ANY UNFORESEEN CONDITIONS WHICH MAY ALTER THE WORK.
- CONTRACTOR SHALL BE RESPONSIBLE FOR COORDINATION OF OTHER TRADES AND WORK BETWEEN THE TRADES TO ENSURE A FULL AND COMPLETE JOB.
- ALL CHANGES IN WORK COMPLETED WITHOUT APPROVAL FROM THE OWNER SHALL BECOME THE RESPONSIBILITY OF THE CONTRACTOR WHO SHALL INCUR ALL COST INVOLVED.
- ALL MATERIALS SHALL BE INSTALLED PER MANUFACTURERS WRITTEN INSTRUCTIONS UNLESS OTHERWISE NOTED (U.O.N.).
- LIKE OR SIMILAR CONDITIONS NOT SPECIFICALLY NOTED SHALL BE CONSTRUCTED IN A MANNER CONSISTENT W/ LIKE OR SIMILAR WORK/ DETAILS.
- UNDERCUT DOOR TO TRASH CHUTE TO AVOID FLOOR DAMAGE
- PROVIDE ACCESSIBLE TRANSITION STRIPS AT EVERY FLOOR MATERIAL CHANGE
- PROVIDE NEW WALL BASE. USE PREFORMED CORNERS ANYWHERE THERE IS A BULLNOSE BASE OR WHERE TWO WALLS MEET. PATCH AND REPAIR ANY DAMAGED PAINT AT WALL BASE

BASE BID

DEMOLITION OF THE EXISTING FLOORING AND INSTALLATION OF NEW FLOORING THROUGHOUT THE COMMON AREAS OF LEVELS 1 AND 2, INCLUDING LAUNDRY AREA ON LEVEL 1

ADDITIVE ALTERNATE

- DEMOLITION OF THE EXISTING FLOORING AND INSTALLATION OF NEW FLOORING OF PUBLIC RESTROOMS ON LEVEL 1
- DEMOLITION OF EXISTING FLOORING AND INSTALLATION OF NEW FLOORING THROUGHOUT THE COMMON AREAS OF LEVELS 3,4,5
- CLEAN CONCRETE IN ALL THE STAIRWELLS

APPLICABLE CODES + STANDARDS

VIRGINIA UNIFORM STATEWIDE BUILDING CODE 2018

VIRGINIA UNIFORM STATEWIDE EXISTING BUILDING CODE 2018

ICC / ANSI A117.1, ACCESSIBLE AND USABLE BUILDINGS AND FACILITIES 2017

VIRGINIA ENERGY CONSERVATION CODE COMPLIANCE STATEMENT
THE 2015 VIRGINIA ENERGY CONSERVATION CODE OFFERS MULTIPLE DIFFERENT PATHS TO COMPLIANCE. THE CHOSEN COMPLIANCE PATH APPLIES TO THE COMPLETE PROJECT IN ITS ENTIRETY AND SHALL BE IDENTIFIED ON THE CONSTRUCTION DOCUMENTS.

MATERIAL LEGEND

- BRICK - ELEVATION
- BRICK - PLAN
- CMU - PLAN
- CONCRETE
- GROUT
- GYPSUM WALLBOARD
- INSUL - BATT
- INSUL - RIGID
- PLYWOOD
- STEEL
- WOOD

ABBREVIATIONS

- AFF ABOVE FINISH FLOOR
- ACT ACOUSTICAL CEILING TILE
- ARCH ARCHITECTURAL
- CJ CONTROL JOINT
- CT CERAMIC TILE
- CONC CONCRETE
- CONT CONTINUOUS
- CMU CONCRETE MASONRY UNIT
- DEMO DEMOLITION
- DIA DIAMETER
- DIM DIMENSION
- DWG DRAWING
- EWC ELECTRICAL WATER COOLER
- EQ EQUAL
- FEC FIRE EXTINGUISHER CABINET
- GWFB GYPSUM WALL BOARD
- MFR MANUFACTURER
- MO MASONRY OPENING
- MECH MECHANICAL
- MIN MINIMUM
- NIC NOT IN CONTRACT
- NTS NOT TO SCALE
- OC ON CENTER
- REF REFERENCE
- RO ROUGH OPENING
- SIM SIMILAR
- SPEC SPECIFICATION
- STRUCT STRUCTURAL
- TYP TYPICAL
- UON UNLESS OTHERWISE NOTED
- VIF VERIFY IN FIELD

ARCHITECTURAL SYMBOLS

- BUILDING/WALL/DETAIL SECTION # SHEET # WHERE SECTION IS DRAWN
- PLAN NUMBER AND SHEET
- ENLARGED PLAN/DETAIL LOCATION WITH SHEET TAKEN AND SHEET SHOWN
- ELEVATION TAG SHEET # WHERE SECTION IS DRAWN
- ELEVATION TAG SHEET # WHERE ELEVATION IS DRAWN
- FLOOR LEVEL / ELEVATION
- ROOM TAG ROOM # ROOM SQUARE FOOTAGE
- ALIGN WALL TYPE FIRE RATING
- DOOR TYPE
- WINDOW TYPE
- STOREFRONT TYPE
- KEYED NOTE
- DEMOLITION NOTE
- NEW WORK NOTE
- EXISTING DOOR
- NEW DOOR
- EXISTING WALL / STRUCTURE
- WALL TO BE DEMOLISHED
- NEW WALL
- NORTH ARROW

PROJECT INFORMATION

HEIGHT AND AREA TABULATIONS			
EXISTING BUILDING	PROPOSED COMPLETED BUILDING		
FIRST FLOOR 16,150 SF	FIRST FLOOR 16,150 SF		
SECOND FLOOR 16,150 SF	SECOND FLOOR 16,150 SF		
THIRD FLOOR 16,150 SF	THIRD FLOOR 16,150 SF		
FOURTH FLOOR 16,150 SF	FOURTH FLOOR 16,150 SF		
FIFTH FLOOR 16,150 SF	FIFTH FLOOR 16,150 SF		
5 STORIES	5 STORIES		

PROJECT DESCRIPTION

THE PROJECT CONSISTS OF UPDATING THE COMMON AREA FLOORING OF THE EXISTING CHOREY PARK APARTMENT COMPLEX, A 5-STORY, 100-UNIT APARTMENT BUILDING HOUSING ELDERLY RESIDENTS. VIA WILL PROVIDE ARCHITECTURAL/INTERIOR DESIGN SERVICES FOR THE DEMOLITION OF THE EXISTING FLOORING AND THE INSTALLATION OF NEW FLOORING THROUGHOUT THE COMMON AREAS OF FLOORS 1 THROUGH 5 AND DEVELOP A SET OF CONSTRUCTION DOCUMENTS FOR BIDDING AND IMPLEMENTATION OF THE WORK.

SUFFOLK REDEVELOPMENT HOUSING AUTHORITY
CHOREY PARK FLOORING
804 W CONSTANCE RD, SUFFOLK, VA 23434


REVISIONS	DATE	DESCRIPTION
#		

VIA PROJ #: 21047-03
DATE: 03/01/2024
CHECKED BY: Checker
SHEET STATUS: PERMIT SET

KEY PLAN:

SHEET TITLE: TITLE SHEET

SHEET NUMBER:
T100

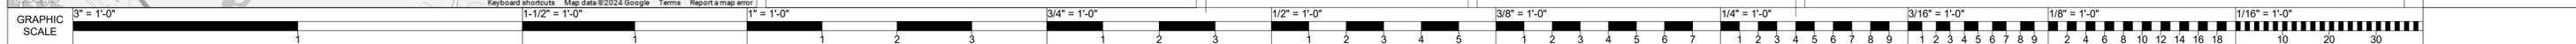

DIVISION 02 - EXISTING CONDITIONS

SECTION 024100
DEMOLITION

PART 1 GENERAL

1.01 SUBMITTALS

- A. Site Plan: Indicate:
- B. Project Record Documents: Accurately record actual locations of capped and active utilities and subsurface construction.

PART 3 EXECUTION

2.01 GENERAL PROCEDURES AND PROJECT CONDITIONS

- A. Comply with applicable codes and regulations for demolition operations and safety of adjacent structures and the public.
 1. Obtain required permits.
 2. Take precautions to prevent catastrophic or uncontrolled collapse of structures to be removed; do not allow worker or public access within range of potential collapse of unstable structures.
 3. Provide, erect, and maintain temporary barriers and security devices.

2.02 SELECTIVE DEMOLITION FOR ALTERATIONS

- A. Existing construction and utilities indicated on drawings are based on casual field observation and existing record documents only.
- B. Remove existing work as indicated and required to accomplish new work.
- C. Services including, but not limited to, HVAC, Plumbing, Fire Protection, Electrical, and Telecommunications: Remove existing systems and equipment as indicated.
- D. Protect existing work to remain.

2.03 DEBRIS AND WASTE REMOVAL

- A. Remove debris, junk, and trash from site.

END OF SECTION

DIVISION 03 - CONCRETE

SECTION 030100
MAINTENANCE OF CONCRETE

PART 1 GENERAL

1.01 Section Includes

- A. Cleaning of existing concrete surfaces.
- B. Resurfacing of concrete surfaces having spalled areas and other damage.
- C. Scope of Work: As indicated on drawings.

PART 2 PRODUCTS

2.01 Cleaning Materials

- A. Detergent: Non-ionic detergent.

2.02 Cementitious Patching and Repair Materials

- A. Cementitious Repair Mortar, Trowel Grade: One- or two-component, factory-mixed, polymer-modified cementitious mortar.

PART 3 EXECUTION

3.01 Cleaning Existing Concrete

- A. Clean concrete surfaces of dirt or other contamination using the gentlest method that is effective.
 1. Try the gentlest method first, then, if not clean enough, use a less gentle method taking care to watch for impending damage.
 2. Clean out cracks and voids using same methods.
- B. The following are acceptable cleaning methods, in order from gentlest to less gentle:
 1. Water washing using low-pressure, maximum of 100 psi, and, if necessary, brushes with natural or synthetic bristles.
 2. Increasing the water washing pressure to maximum of 400 psi.
 3. Adding detergent to washing water; with final water rinse to remove residual detergent.
 4. Steam-generated low-pressure hot-water washing.

3.02 Concrete Surface Repair Using Cementitious Materials

- A. Clean concrete surfaces, cracks, and joints of dirt, laitance, corrosion, and other contamination using method(s) specified above and allow to dry.
- B. Apply coating of bonding agent to entire concrete surface to be repaired.
- C. Apply repair mortar by steel trowel to a minimum thickness of 1/4 inch (6 mm) over entire surface, terminating at a vertical change in plane on all sides.
- D. Trowel finish to match adjacent concrete surfaces.

END OF SECTION

DIVISION 07 - THERMAL AND MOISTURE PROTECTION

SECTION 079200
JOINT SEALANTS

PART 1 GENERAL

1.01 SUBMITTALS

- A. Product Data: Submit manufacturer's technical datasheets for each product to be used; include the following:
 1. Physical characteristics, including movement capability, VOC content, hardness, cure time, and color availability.
 2. List of backing materials approved for use with the specific product.
 3. Backing material recommended by sealant manufacturer.
 4. Substrates that product is known to satisfactorily adhere to and with which it is compatible.
 5. Substrates the product should not be used on.
- B. Preinstallation Field Adhesion Test Reports: Submit filled out Preinstallation Field Adhesion Test Reports log within 10 days after completion of tests; include bagged test samples and photographic records.

1.02 WARRANTY

- A. See Section 017800 - Closeout Submittals for additional warranty requirements.

PART 2 PRODUCTS

2.01 JOINT SEALANTS - GENERAL

- A. Sealants and Primers: Provide products having lower volatile organic compound (VOC) content than indicated in SCAQMD 1168.

2.02 NONSAG JOINT SEALANTS

- A. Mildew-Resistant Silicone Sealant: ASTM C920, Grade NS, Uses M and A; single component, mildew resistant, not expected to withstand continuous water immersion or traffic.
 1. Color: Clear
- B. Polyurethane Sealant: ASTM C920, Grade NS, Uses M and A; single or multicomponent; explicitly approved by manufacturer for continuous water immersion; suitable for traffic exposure when recessed below traffic surface.
 1. Movement Capability: Plus and minus 35 percent, minimum.

2.03 ACCESSORIES

- A. Sealant Backing Materials, General: Materials placed in joint before applying sealants; assists sealant performance and service life by developing optimum sealant profile and preventing three-sided adhesion; type and size recommended by sealant manufacturer for compatibility with sealant, substrate, and application.
- B. Overlay Extrusion for Glazing System Joint Protection: Rubber profiled extrusions placed over joints in glazing system and provided with watertight seal.
 1. Profile: As required to match existing metal glazing cap requirements.

PART 3 EXECUTION

3.01 EXAMINATION

- A. Preinstallation Adhesion Testing: Install a sample for each test location indicated in the test plan.
 1. Test each sample as specified in PART 1 under QUALITY ASSURANCE article.
 2. Notify Architect of date and time that tests will be performed, at least seven days in advance.
 3. Record each test on Preinstallation Adhesion Test Log as indicated.
 4. If any sample fails, review products and installation procedures, consult manufacturer, or take other measures that are necessary to ensure adhesion; retest in a different location; if unable to obtain satisfactory adhesion, report to Architect.
 5. After completion of tests, remove remaining sample material and prepare joints for new sealant installation.

3.02 INSTALLATION

- A. Install this work in accordance with sealant manufacturer's requirements for preparation of surfaces and material installation instructions.
- B. Provide joint sealant installations complying with ASTM C1193.
- C. Install bond breaker backing tape where backer rod cannot be used.
- D. Install sealant free of air pockets, foreign embedded matter, ridges, and sags, and without getting sealant on adjacent surfaces.
- E. Nonsag Sealants: Tool surface concave, unless otherwise indicated; remove masking tape immediately after tooling sealant surface.

END OF SECTION

DIVISION 09 - FINISHES

SECTION 096500
RESILIENT FLOORING

PART 1 GENERAL

1.01 SUBMITTALS

- A. Product Data: Provide data on specified products, describing physical and performance characteristics; including sizes, patterns and colors available; and installation instructions.
- B. Shop Drawings: Indicate seaming plans and floor patterns.
- C. Selection Samples: Submit manufacturer's complete set of color samples for Architect's initial selection.

PART 2 PRODUCTS

2.01 SHEET FLOORING

- A. Linoleum Sheet Flooring: Homogeneous wear layer bonded to backing, with color and pattern through wear layer thickness.
 1. Minimum Requirements: Comply with ASTM F2034, Type corresponding to type specified.
 2. Backing: Jute fabric.
 3. Thickness: 0.100 inch (2.5 mm), minimum, excluding backing.
 4. Sheet Width: 79 inch (2000 mm), minimum.
 5. Color: To be selected by Architect from manufacturer's full range.

2.02 TILE FLOORING

- A. Luxury Vinyl Tile
 1. Minimum Requirements: Comply with ASTM F1700, Class III.
 2. Plank Tile Size: 8 by 48 inch (200 by 1200 mm).
 3. Wear Layer Thickness: 0.02 inch (0.55 mm).
 4. Total Thickness: 0.15 inch (4 mm).
 5. Color: To be selected by Architect from manufacturer's full range.

2.03 RESILIENT BASE

- A. Resilient Base: ASTM F1861, Type TP, rubber, thermoplastic; style as scheduled.
 1. Height: 4 inches (100 mm).
 2. Thickness: 0.125 inch (3.2 mm).
 3. Finish: Satin.
 4. Color: To be selected by Architect from manufacturer's full range.

2.04 ACCESSORIES

- A. Subfloor Filler: White premix latex; type recommended by adhesive material manufacturer.
- B. Primers, Adhesives, and Seam Sealer: Waterproof; types recommended by flooring manufacturer.
- C. Moldings, Transition and Edge Strips: Same material as flooring.
- D. Sealer and Wax: Types recommended by flooring manufacturer.

PART 3 EXECUTION

3.01 Installation - General

- A. Starting installation constitutes acceptance of subfloor conditions.

- B. Install in accordance with manufacturer's written instructions.

3.02 Installation - Sheet Flooring

- A. Lay flooring with joints and seams parallel to longer room dimensions, to produce minimum number of seams. Lay out seams to avoid widths less than 1/3 of roll width; match patterns at seams.

3.03 Installation - Tile Flooring

- A. Mix tile from container to ensure shade variations are consistent when tile is placed, unless otherwise indicated in manufacturer's installation instructions.

3.04 Installation - Resilient Base

- A. Fit joints tightly and make vertical. Maintain minimum dimension of 18 inches (45 mm) between joints.

END OF SECTION


FINISH SCHEDULE

Name	Base Finish	Floor Finish	Area
COMMONS	WB-1	LVT-1	580 SF
CORRIDOR LEVEL 1	WB-1	LVT-1	1545 SF
CORRIDOR LEVEL 2	WB-1	LVT-1	1514 SF
DRYERS	WB-1	LINO-1	41 SF
LAUNDRY	WB-1	LINO-1	226 SF
LOBBY	WB-1	LVT-1	171 SF
MENS	WB-1	LINO-1	133 SF
TRASH	WB-1	LVT-1	35 SF
VEST 1	WB-1	LVT-1	74 SF
VEST 2	WB-1	LVT-1	35 SF
WOMENS	WB-1	LINO-1	146 SF


FINISH PRODUCTS

TAG	DESCRIPTION	MANUFACTURER	PRODUCT + COLOR
WB-1	WALL BASE	FORBO	ARCH TO SELECT
LVT-1	LUXURY VINYL TILE	FORBO	ALLURA FLEX-ARCH TO SELECT
LINO-1	LINOLEUM	FORBO	MARMOLEUM-ARCH TO SELECT


FINISH DETAILS

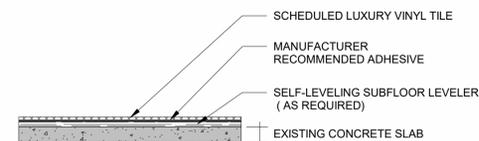


1 FLOOR INSTALLATION- LVT DETAILS
3" = 1'-0"

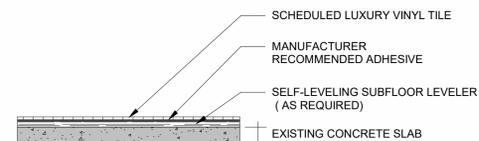


2 FLOOR INSTALLATION- LINO DETAILS
3" = 1'-0"

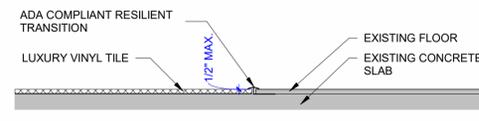


3 LVT TO EXISTING FLOOR TRANSITION
3" = 1'-0"

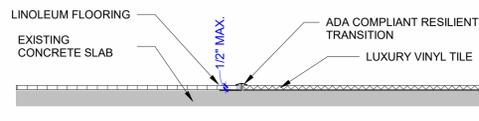


4 LINOLEUM TO LVT TRANSITION DETAIL
3" = 1'-0"

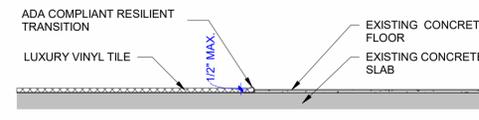

5 LVT TO CONCRETE FLOOR TRANSITION
3" = 1'-0"

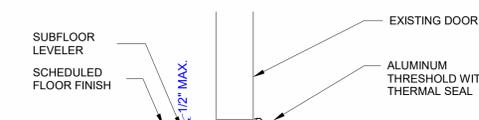

6 TYPICAL TRANSITION AT EXTERIOR DOOR THRESHOLD
3" = 1'-0"

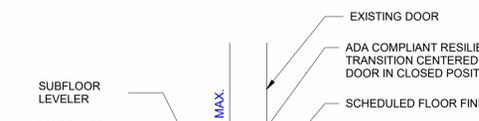

7 TYPICAL TRANSITION AT INTERIOR DOOR THRESHOLD
3" = 1'-0"



CONSULTANT:

SUFFOLK REDEVELOPMENT HOUSING AUTHORITY

CHOREY PARK FLOORING

804 W CONSTANCE RD, SUFFOLK, VA 23434

REVISIONS	DESCRIPTION
#	DATE

VIA PROJ #: 21047-03

DATE: 03/01/2024

CHECKED BY: Checker

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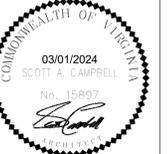
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KEY PLAN:

SHEET TITLE:
SPECIFICATIONS AND
FINISH SCHEDULE+DETAILS

SHEET NUMBER:

T101



CONSULTANT:

SUFFOLK REDEVELOPMENT HOUSING AUTHORITY
CHOREY PARK FLOORING
 804 W CONSTANCE RD, SUFFOLK, VA 23434


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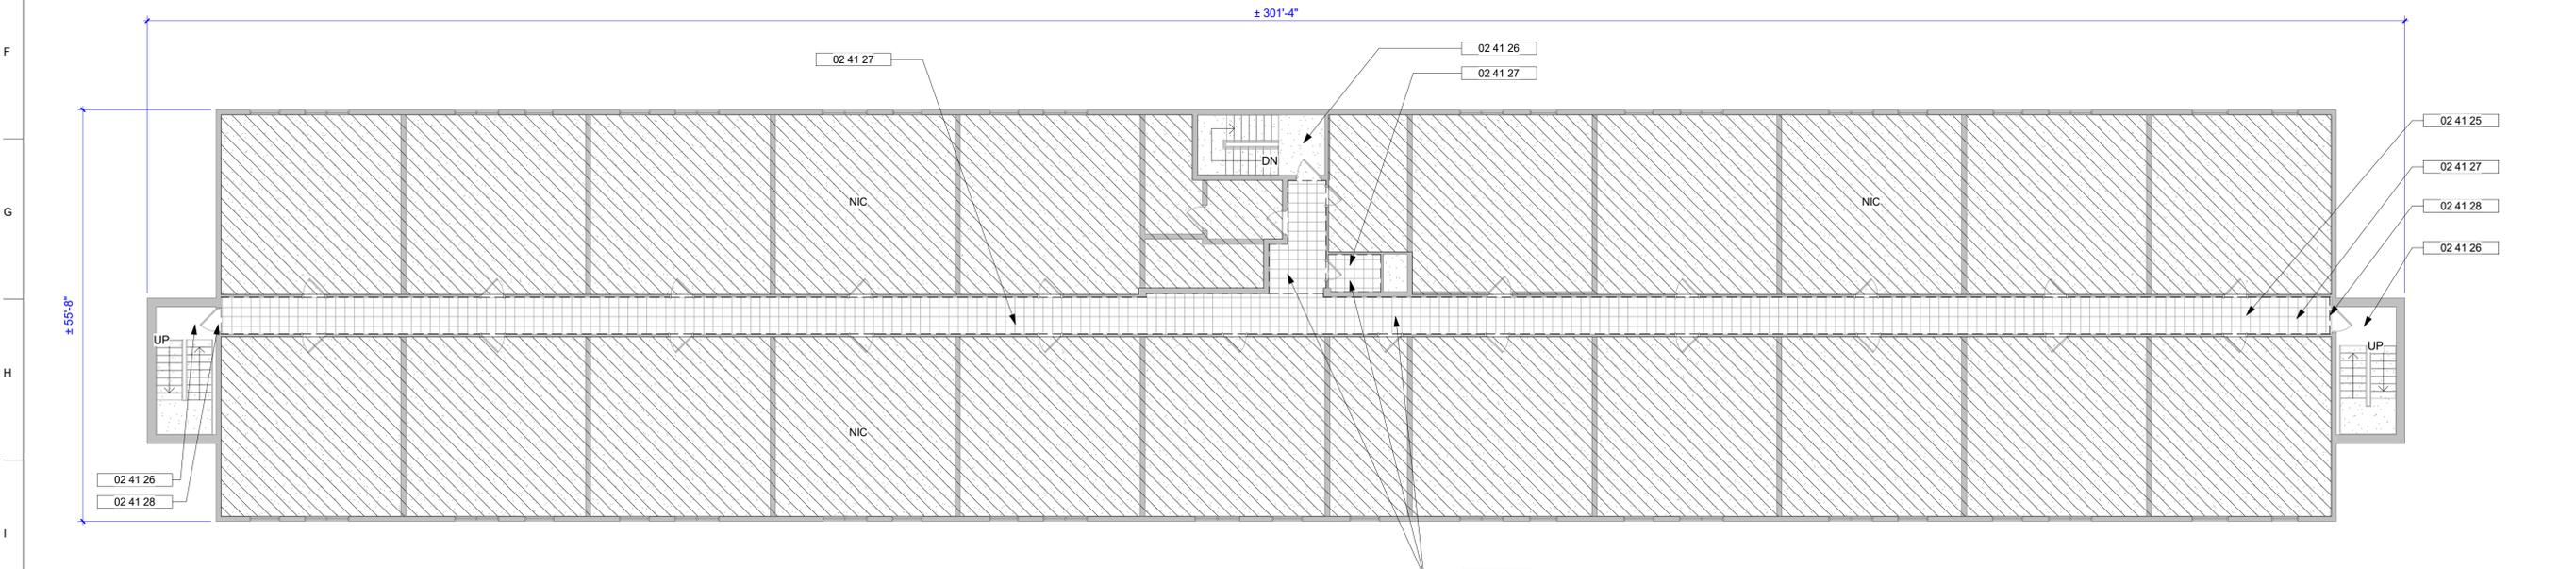
KEY PLAN:

SHEET TITLE:
 LEVEL 1
 DEMOLITION-FLOOR PLAN

SHEET NUMBER:
AD101



1 LEVEL 1-DEMOLITION FLOOR PLAN
 AD101 3/32" = 1'-0"

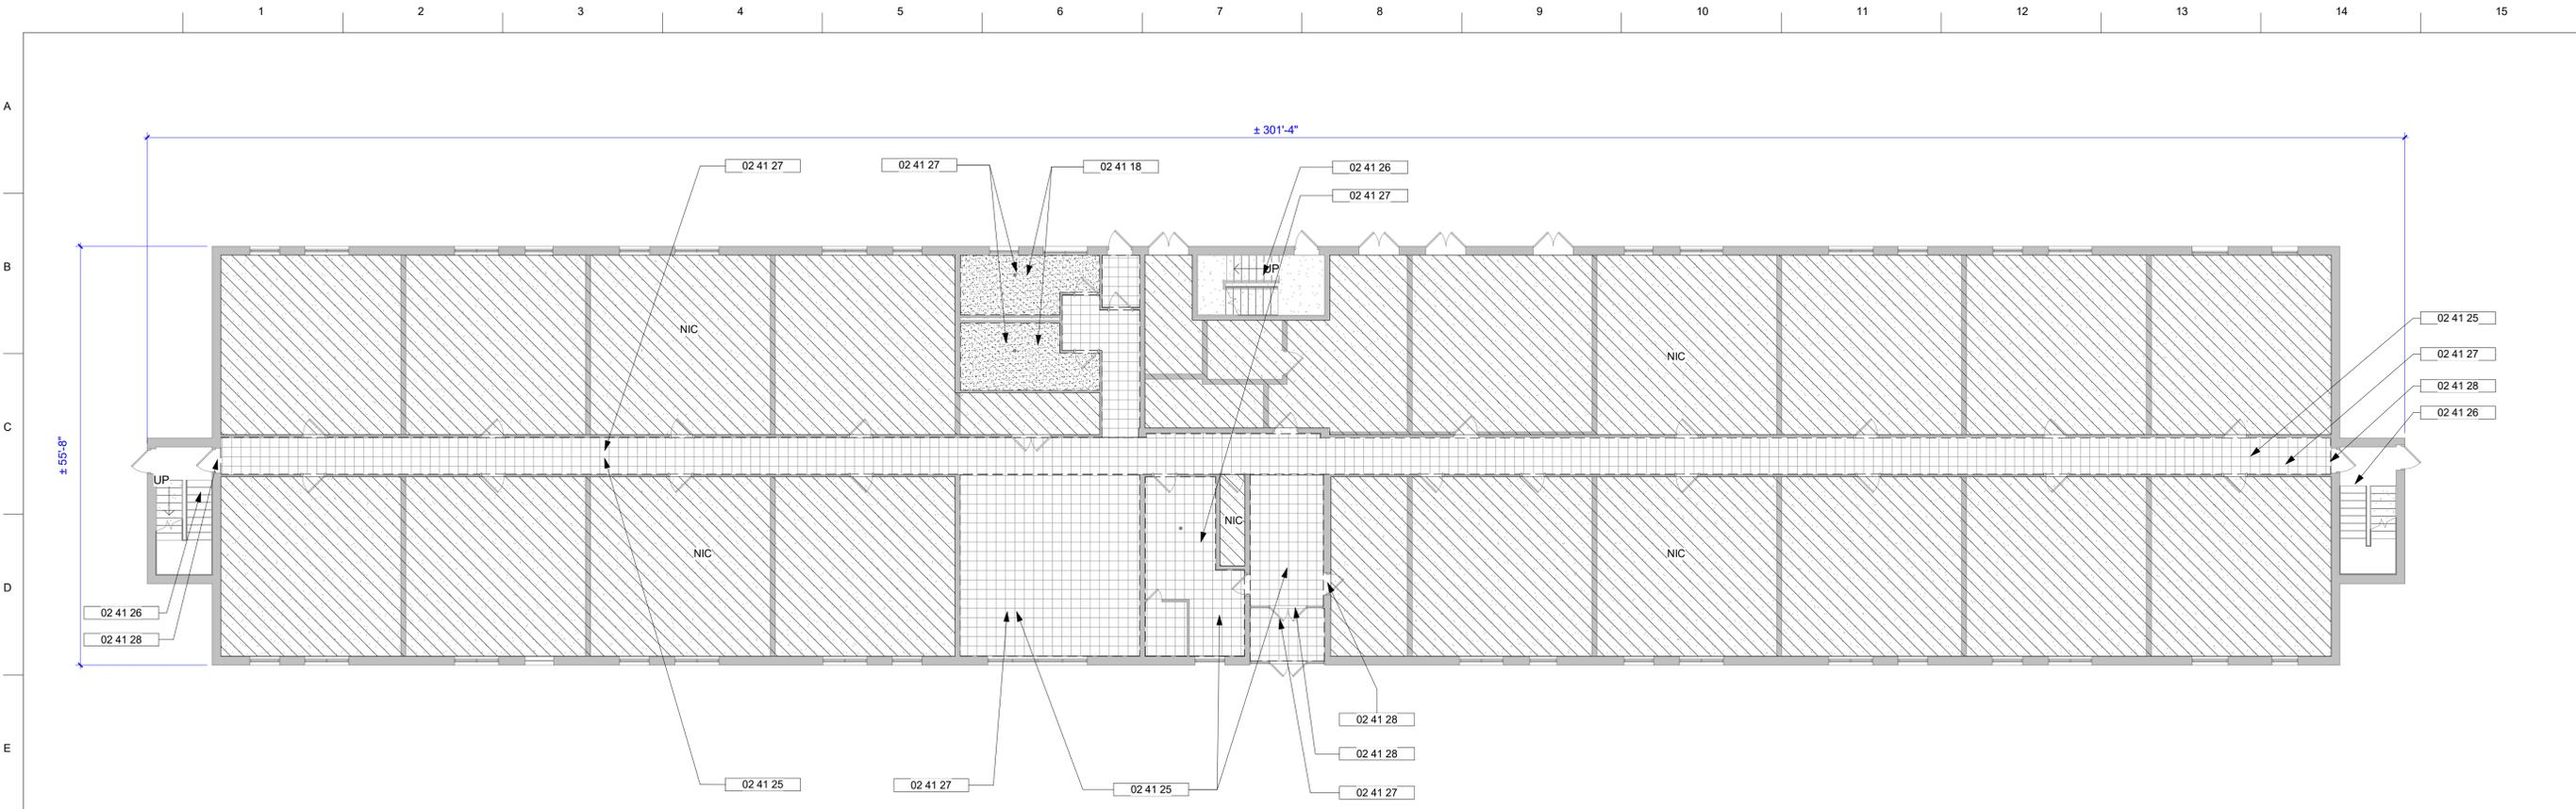


3 LEVEL 2-5 DEMOLITION-FLOOR PLAN
 AD101 3/32" = 1'-0"

KEYNOTES - DEMOLITION

02 41 18	DEMOLISH EXISTING SHEET VINYL FLOORING IN RESTROOMS AND ASSOCIATED ADHESIVES AND FASTENERS TO EXTENTS INDICATED ON DRAWINGS. PREPARE FOR NEW WORK
02 41 25	DEMOLISH EXISTING VCT FLOORING AND ASSOCIATED ADHESIVES AND FASTENERS TO EXTENTS INDICATED ON DRAWINGS. PREPARE FOR NEW WORK
02 41 26	CLEAN CONCRETE ON EXISTING STAIRS AND FLOOR IN STAIRWELLS "ADDITIVE ALTERNATE"
02 41 27	CLEAN OFF ALL DIRT, DEBRIS AND BUILD-UP FROM EXISTING FLOORING TO EXTENTS INDICATED ON DRAWINGS. PREPARE FOR NEW WORK
02 41 28	DEMOLISH TRANSITION STRIPS AND WALL BASE, FASTENERS AND ADHESIVE TO EXTENTS INDICATED ON DRAWINGS. PREPARE FOR NEW WORK

FLOOR MATERIAL LEGEND

	VINYL COMPOSITE TILE (VCT)
	SHEET VINYL FLOORING
	CONCRETE SUB-FLOOR

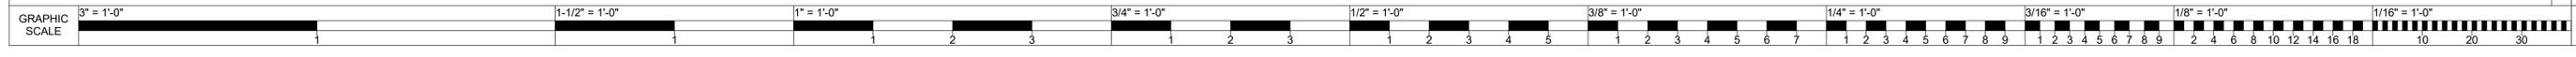



CONSULTANT:

SUFFOLK REDEVELOPMENT HOUSING AUTHORITY
CHOREY PARK FLOORING
 804 W CONSTANCE RD, SUFFOLK, VA 23434


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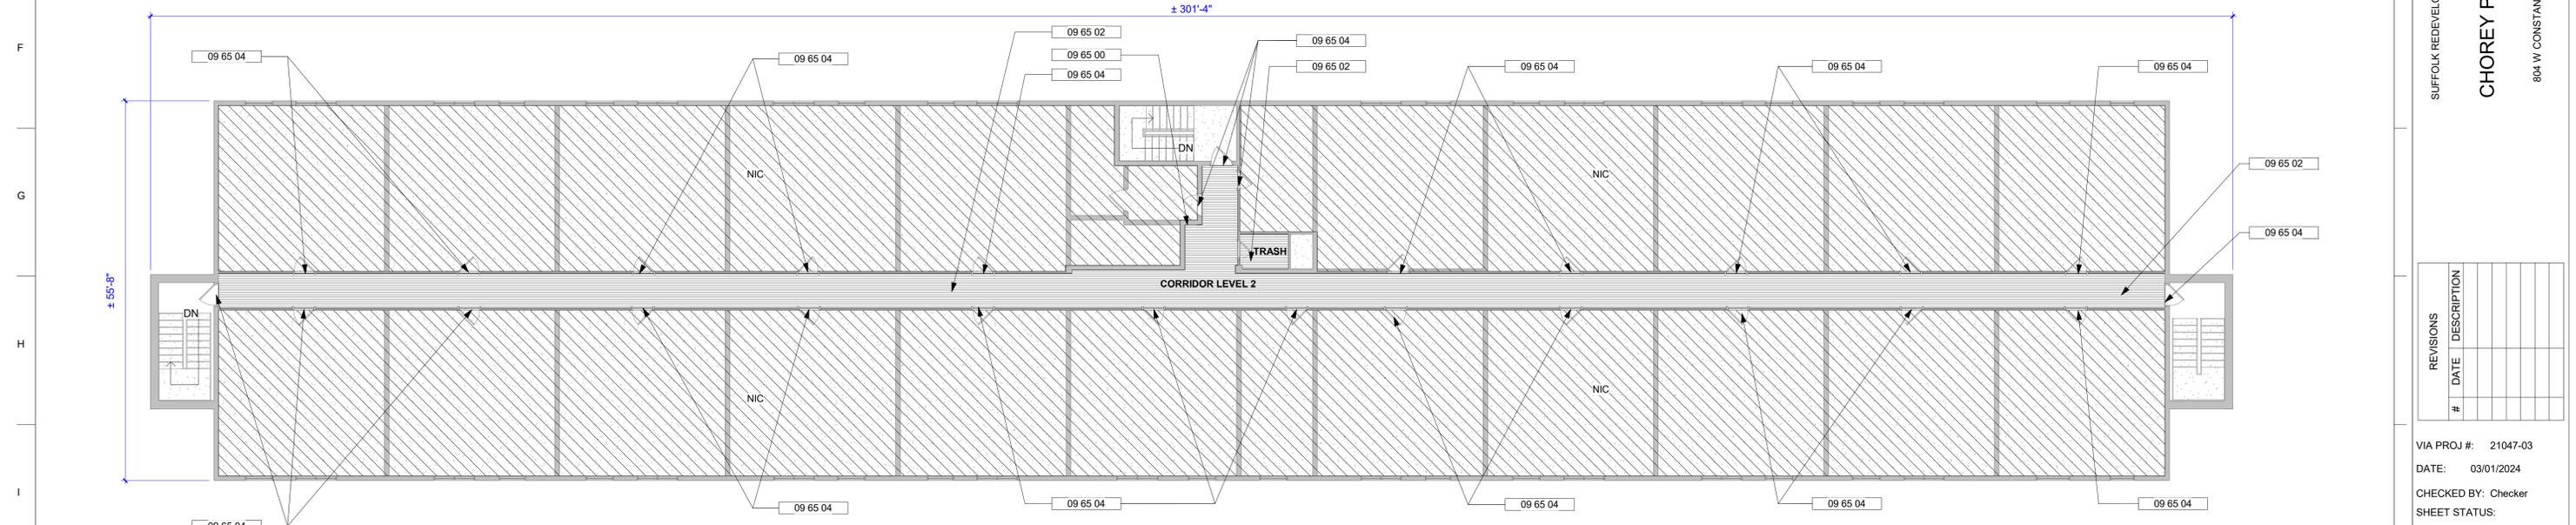
KEY PLAN:

SHEET TITLE:
 LEVEL 1 NEW WORK-FLOOR PLAN

SHEET NUMBER:
A101



1 LEVEL 1 NEW WORK FLOOR PLAN
 3/32" = 1'-0"

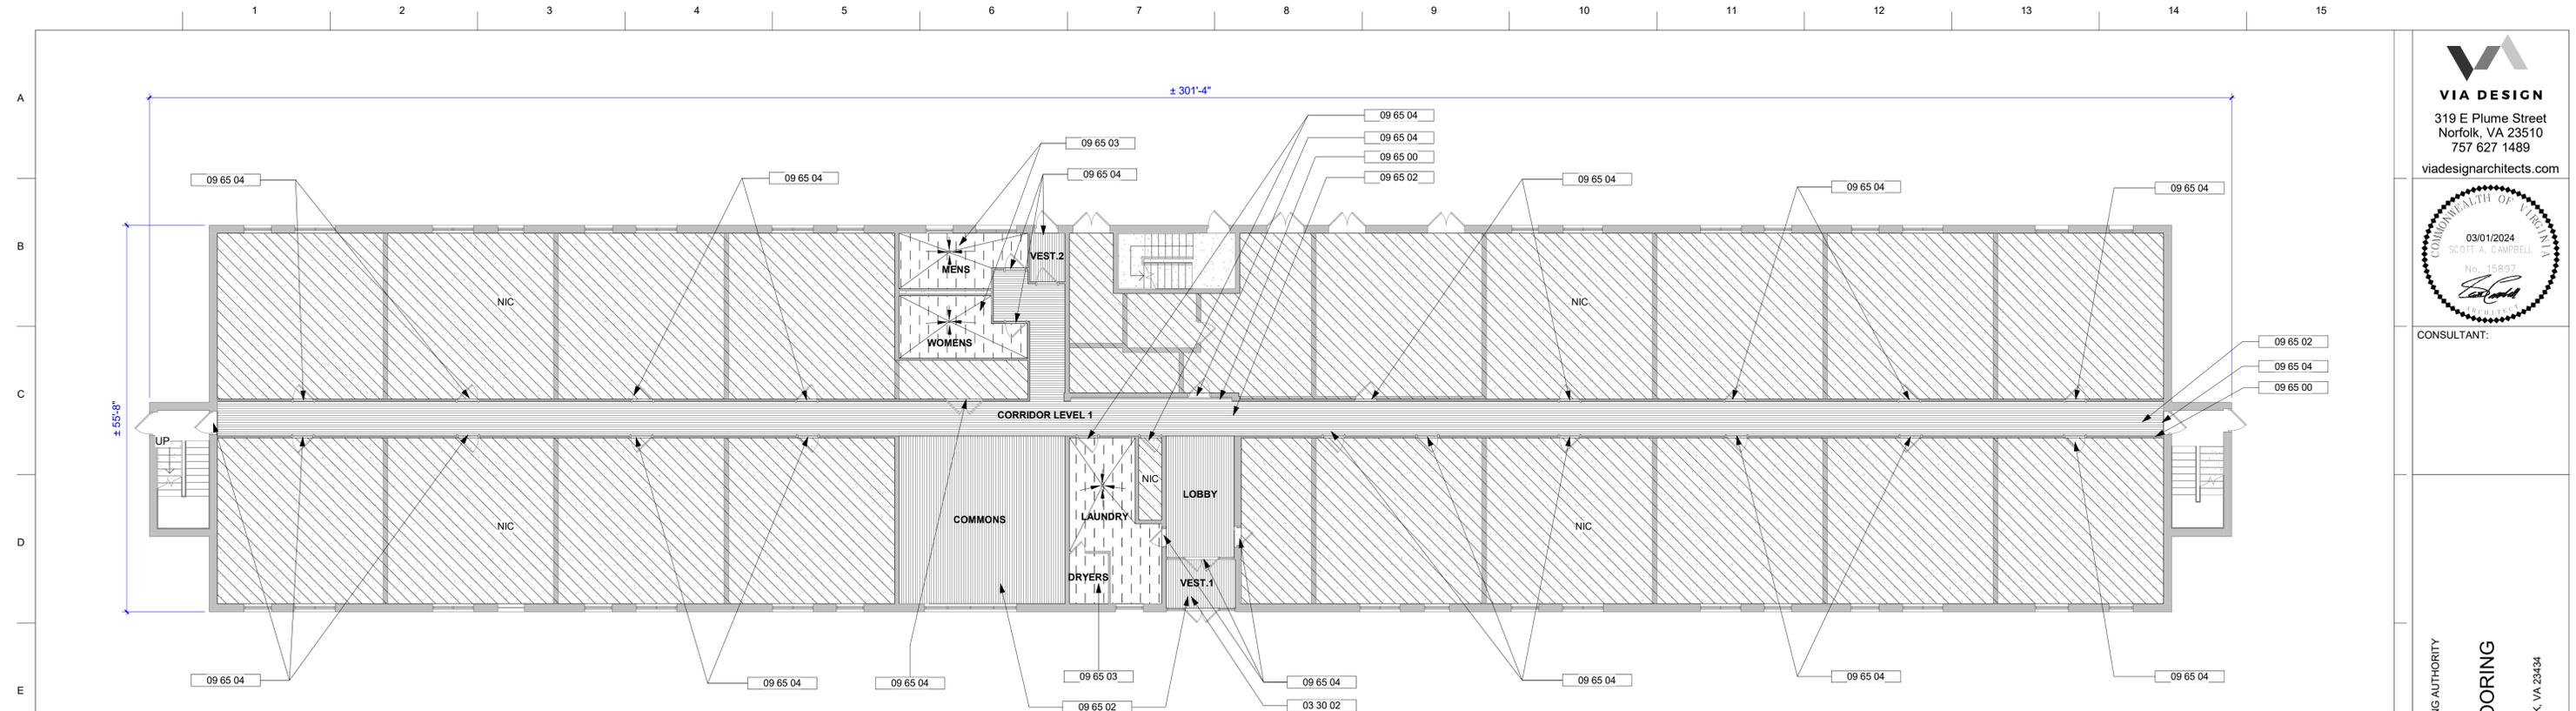

3 LEVEL 2-5 NEW WORK FLOOR PLAN
 3/32" = 1'-0"

KEYNOTES - NEW WORK

03 30 02	REPAIR DAMAGED SUBFLOOR AT ENTRY VESTIBULE BEFORE INSTALLING NEW LVT
09 65 00	PROVIDE NEW WALL BASE. USE PREFORMED CORNERS ANYWHERE THERE IS A BULLNOSE BASE OR WHERE TWO WALLS MEET
09 65 02	INSTALL NEW LVT PER MANUFACTURER'S RECOMMENDATION.
09 65 03	INSTALL NEW LINOLEUM FLOORING. MAINTAIN SLOPE TO DRAIN
09 65 04	INSTALL NEW ACCESSIBLE TRANSITION STRIPS AT EVERY FLOOR MATERIAL CHANGE

FLOOR MATERIAL LEGEND

	LUXURY VINYL TILE (LVT)
	LINOLEUM SHEET FLOORING
	CONCRETE SUB-FLOOR

